


CIVIL & STORMWATER WORKS for 99 ISABELLA STREET WINGHAM NSW 2429



Prepared by

WALLACE INFRASTRUCTURE DESIGN PTY LTD

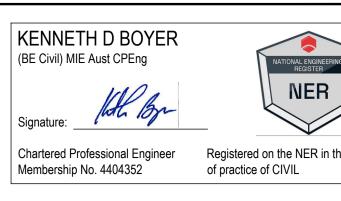

DRAWING NUMBER	DRAWING DESCRIPTION
C01.01	LEGEND, DRAWING SCHEDULE AND LOCATION PLAN
C02.01	GENERAL NOTES
C04.01	SITE DETAIL PLAN
C04.02	SAFE INTERSECTION SIGHT DISTANCE ASSESSMENT
C05.01	STORMWATER MANAGEMENT PLAN
C06.01	RAINWATER TANK TYPICAL SECTION & DETAILS

ABBREVIATIONS

A/G AGG ARCH	ABOVE GROUND AGGREGATE ARCHITECT	IFC IFCR IL	ISSUED FOR CONSTRUCTION ISSUED FOR CLIENT REVIEW INVERT LEVEL	SV SW SWP
ASP	ASPHALT	IO	INSPECTION OPENING	THK
BM	BENCHMARK	KIP	KERB INLET PIT	TJ
CAD	COMPUTER AIDED DRAFTING	L	LENGTH	TOW
C-C	CENTRE TO CENTRE	_ LP	LAMP POST (SURVEY)	TW
CH	CHAINAGE	MAX	MAXIMUM	TYP
CI	CAST IRON	MC	MASS CONCRETE	U/G
CJ	CONSTRUCTION JOINT	MH	MANHOLE	UNO
CL	COVER LEVEL or CENTRE LINE	MIN	MINIMUM	U/S
CO	CLEAN OUT (SUBSOIL)	MISC	MISCELLANEOUS	VC
COG	CHANGE OF GRADE	N	NORTH	VP
CONC	CONCRETE	NRV	NON RETURN VALVE	VR
CTRL	CONTROL	NTS	NOT TO SCALE	W
CR	CROWN	OD	OUTER DIAMETER	WC
CTS	CENTRES	OF	OVERFLOW	WL
D	DEPTH	OH	OVERHEAD	WM
DIA	DIAMETER	PP	POWER POLE	WS
DP	DOWNPIPE	PPE	PERSONAL PROTECTIVE EQUIP.	
DRG	DRAWING	PVC	POLYVINYLCHLORIDE	<u>UNITS</u>
D/S	DOWN STREAM	PV	PRESSURE VENT	mm
DTM	DIGITAL TERRAIN MODEL	PVP	PRESSURE VENT PIPE	cm
EB	EDGE BITUMIN	QA	QUALITY ANALYSIS	m
EX	EXISTING	QTY	QUANTITY	m^2
ESL	EXISTING SURFACE LEVEL	R	RADIUS	m^3
FH	FIRE HYDRANT	RC	REINFORCED CONCRETE	L/s
FHR	FIRE HOSE REEL	REV	REVISION	ha
FFL	FINISHED FLOOR LEVEL	RL	REDUCED LEVEL	
FGL	FINISHED GROUND LEVEL	RW	RETAINING WALL	
FSL	FINISHED SURFACE LEVEL	SFW	SEALED FLOOR WASTE	
FW	FLOOR WASTE	SL	SURFACE LEVEL	
GA	GENERAL ARRANGEMENT	SMH	SEWER MANHOLE	

STOP VALVE STORMWATER STORMWATER PIT THICKNESS TRAVERSE JOINT TOP OF WALL TRADE WASTE TYPICAL UNDERGROUND UNLESS NOTED OTHERWISE UPSTREAM VITRIFIED CLAY PIPE VENT PIPE VENT PIPE VERTICAL RISER WIDTH WATER CLOSET WATER METER WASTE STACK	
MILLIMETRES CENTIMETRES METRES	

SQUARE METRES
CUBIC METRES

HECTARES


LITRES PER SECOND

LINETYPES & SYMBOLS	
GENERAL	
SITE BOUNDARY	
CADASTRAL BOUNDARY	
EASEMENT BOUNDARY	
EXISTING FEATURES	
CONTOURS	
STORMWATER PIPE	
STORMWATER PIT	
ELECTRICAL CABLE - U/G	EE-
ELECTRICAL CABLE - O/H	
EXISTING SEWER PIPE	ss-
EXISTING WATER	w w-
EXISTING WATER (HYDRANT)	•
EXISTING WATER (STOP VALVE)	X
EXISTING TELECOM	OFC
COMMUNICATIONS PIT	
EXISTING GAS	G G-
EXISTING BUILDING	
TREES / SHRUBS	
PROPOSED - BUILDING (INDICATIV	<u>/E ONLY)</u>
DWELLING NUMBER	UNIT 01
FINISHED FLOOR LEVEL	FFL 5.00
BUILDING FOOTPRINT	

PROPOSED - UTILITIES					
SEWER	S S				
WATER	w				
COMMUNICATIONS					
COMMUNICATIONS - OPTIC FIBRE	OFC OFC				
COMMUNICATIONS PIT					
GAS	G				
ELECTRICAL CABLE - U/G	—— Е ——				
ELECTRICAL CABLE - O/H	ОНЕ ОНЕ				
REDUNDANT	$(-X \cdot X \cdot X \cdot X \cdot X \cdot X \cdot X \cdot X)$				
PROPOSED - EROSION AND SEDIMENT CONTROL					
SITE EXCLUSION FENCE	[X] - [X] - [X]				
SEDIMENT FENCE					
DIVERSION DRAIN	—>—>—				
STABLISED SITE ACCESS					
MATERIAL STOCKPILE	(//////////////////////////////////////				
SLOPE DIRECTION	>				
GEOTEXTILE INLET FILTER					
MESH AND GRAVEL INLET FILTER					
SANDBAG / HAY BALES					
PROPOSED CONTOURS					

PROPOSED - STORMWATER	
SW PIPE (INCL. DIA/GRADE/LENGTH)	ØXXXmm uPVC X.X% GRADE, X.XXm
SW PIPE - CHARGED (INCL. DIA/GRADE/LENGTH)	ØXXXmm uPVC CHARGE X.X% GRADE, X.XXm
SW PIT - GRATED / JUNCTION	
SW - KERB INLET PIT (INCLUDING LINTEL)	
RAINWATER/REUSE TANK	OR (////)
GROSS POLLUTANT TRAP	(⊠ GPT
GRATED DRAIN	
INFILTRATION TRENCH	
HEADWALL	
SUBSOIL	> >
SW SWALE	—>—>—
PIPE RISER	○ XX
PIPE DROPPER	XX C
OVERLAND FLOW PATH	
SW PIT NUMBER	?
SW CATCHMENT (NUMBER / AREA IN ha)	XX X.XXX

PROPOSED - CIVIL	
CONCRETE	
ASPHALTIC CONCRETE	
SAND	
EARTH	
RIP RAP	
BUILDING / STRUCTURES	
TIMBER	
BLOCK PAVERS	
RETAINING WALL	
KERB RAMP	
VEHICULAR CROSSING	
FENCE	
BATTER	
BOLLARD - TYPE 1 (FIXED)	● B-T1
BOLLARD - TYPE 2 (REMOVABLE)	• B-T2
LINEMARKING - CHEVRON	
EXPANSION JOINT	——— EJ ———
TRAVERSE JOINT	TJ ·
CONTROL JOINT	CJ
FINISHED GRADE LEVELS	25.758
EXISTING GRADE LEVELS	25.710

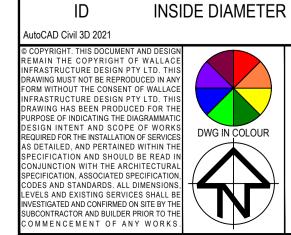

GALVANISED IRON

GARAGE FINISHED LEVEL

INSPECTION CHAMBER

THIS	DRAWING IS NOT APPROVED FOR CONST	RUCTION	UNLESS EN	NDORSED
В	DA APPLICATION ISSUE	14.05.25	KB	-
Α	DA APPLICATION ISSUE	13.05.25	KB	-
REV	DESCRIPTION	DATE	APPV'D	ENDO'D
	B	B DA APPLICATION ISSUE A DA APPLICATION ISSUE REV DESCRIPTION	B DA APPLICATION ISSUE	A DA APPLICATION ISSUE 13.05.25 KB REV DESCRIPTION DATE APPV'D

SEWER MAIN VENT SIDE OUTLET DRAIN

STAINLESS STEEL

STANDARD



D & J CETINIC

37 Patriot Place

Rouse Hill NSW 2155



WALLACE INFRASTRUCTURE
DESIGN PTY LTD

PART OF WALLACE DESIGN GROUP PTY LTD

ABN: 96 154 894 952

PO BOX 23, CHARLESTOWN, NSW 2290
phone: (02) 49 294 109

PROJECT:

CIVIL WORKS for

LOT 01, DP 925163

99 ISABELLA STREET

WINGHAM NSW 2429

MAJOR CONTOUR INTERVAL

MINOR CONTOUR INTERVAL

CIVIL SERVICES

LEGEND, DRAWING SCHEDULE
AND LOCATION PLAN

DRAWING STATUS DA APPROVAL NOT TO BE USED FOR CONSTRUCT					
SCALE:			ORIG. SIZE		
N.T.S.			A1		
DRAWN	DESIGNED	CHECKED	APPROVED	ENDORSED	DATE
MS	AK	KB	KB		14.05.25
PROJECT No. DRAWING No.				REV	
25095 C01.01				В	

GENERAL NOTES

- ALL CONSTRUCTION WORKS ARE TO BE CARRIED OUT IN ACCORDANCE WITH COUNCIL'S ENGINEERING REQUIREMENTS FOR DEVELOPMENTS.
- ALL DIMENSIONS, EASEMENTS AND LOTS SUBJECT TO REGISTRATION OF DEPOSITED PLAN.
 THESE DRAWINGS ARE TO BE READ IN CONJUNCTION WITH ALL ARCHITECTURAL AND
 CONSULTANT'S DRAWINGS AND SPECIFICATIONS, AND OTHER WRITTEN REPORTS (e.g
 GEOTECHNICAL, ARBORIST, ENVIRONMENTAL, ETC.). ANY DISCREPANCY SHALL BE REFERRED
- TO THE ENGINEER BEFORE PROCEEDING WITH ANY WORKS.

 4. ALL LEVELS SHALL BE OBTAINED FROM ESTABLISHED BENCH MARKS AS DIRECTED BY THE SUPERVISOR.
- 5. THE DEVELOPER, SHALL ENSURE ALL ASSOCIATED DOCUMENTATION (GEOTECHNICAL, LANDSCAPE, ARCHITECTURAL, ELECTRICAL, TELECOM, GAS ETC.) HAS BEEN APPROVED FOR CONSTRUCTION BEFORE COMMENCING ANY WORKS.
- 6. THE CONTRACTOR IS RESPONSIBLE FOR THE LOCATION, PROTECTION AND ADJUSTMENT TO ALL IN GROUND AND ABOVE GROUND SERVICES. SEE HUNTER WATER'S NOTICE OF REQUIREMENTS.
- 7. EROSION CONTROL MEASURES, DEVICES, SILT TRAPS. ETC. ARE TO BE INSTALLED BEFORE ANY SITE DISTURBANCE IN ACCORDANCE WITH COUNCIL INSPECTORS REQUIREMENTS AND SITE SEDIMENTATION AND EROSION CONTROL PLANS.
- 8. IT IS THE CONTRACTORS RESPONSIBILITY TO ENSURE THAT ALL WORKS ARE CARRIED OUT IN ACCORDANCE WITH THE WORK HEALTH SAFETY ACT.
- 9. VEHICULAR ACCESS AND ALL SERVICES ARE TO BE MAINTAINED AT ALL TIMES TO ADJOINING PROPERTIES AFFECTED BY CONSTRUCTION WORKS.
- 10. ALL WASTE OR DEMOLISHED MATERIALS SHALL BE DISPOSED OF OFF SITE TO A COUNCIL
- APPROVED SITE. ALL FEES AND CHARGES SHALL BE INCLUDED IN THE CONTRACT SUM.

 11. CONSTRUCTION VIBRATION TO COMPLY WITH AS2760.1-2004 AND/OR NSW DEPT OF
- ENVIRONMENT AND CONSERVATION NOISE REQUIREMENTS
- 12. EMISSIONS FROM SITE ARE NOT TO INTERFERE WITH THE AMENITY OF THE NEIGHBORHOOD.
- 13. NOISE EMISSIONS ARE TO COMPLY WITH NSW EPA NOISE CONTROL MANUAL. TIME RESTRICTIONS APPLY TO CONSTRUCTION WORKS AS FOLLOWS: 7AM TO 6PM MON-FRI; 8AM TO 1PM SAT.
- 14. TREES & SHRUBS WHICH ARE FELLED SHALL BE SALVAGED FOR RE-USE, EITHER IN LOG FORM, OR AS A WOODCHIP MULCH FOR EROSION CONTROL AND/OR SITE REHABILITATION.

 NON-SALVAGEABLE MATERIAL SUCH AS ROOTS & STUMPS SHALL BE DISPOSED OF IN AN APPROVED MANNER.
- 15. 'ESCP' REFERS TO EROSION AND SEDIMENT CONTROL PLAN, 'SWMP' REFERS TO SOIL AND WATER MANAGEMENT PLAN, AND, 'ESC' REFERS TO EROSION AND SEDIMENT CONTROL.
- 16. SEDIMENT, INCLUDES, BUT IS NOT LIMITED TO, CLAY, SILT, SAND, GRAVEL, SOIL, MUD, CEMENT AND CERAMIC WASTE.
- 17. ANY REFERENCE TO THE BLUE BOOK REFERS TO "MANAGING URBAN STORMWATER SOILS AND CONSTRUCTION", LANDCOM, 2004.
- 18. ANY REFERENCE TO THE IECA WHITE BOOKS (2008) REFERS TO IECA 2008, "BEST PRACTICE EROSION AND SEDIMENT CONTROL". BOOKS 1-6. INTERNATIONAL EROSION CONTROL ASSOCIATION (AUSTRALASIA), PICTON, NSW.
- 19. ANY MATERIAL DEPOSITED IN ANY CONSERVATION AREA FROM WORKS ASSOCIATED WITH THE DEVELOPMENT SHALL BE REMOVED IMMEDIATELY BY MEASURES INVOLVING MINIMAL GROUND AND/OR VEGETATION DISTURBANCES AND NO MACHINERY, OR FOLLOWING DIRECTIONS BY COUNCIL AND/OR WITHIN A TIMEFRAME ADVISED BY COUNCIL.

SURVEY NOTES

- 1. THE EXISTING SURVEY CONDITIONS SHOWN ON THESE DRAWINGS HAVE BEEN DERIVED FROM SURVEY INFORMATION SUPPLIED BY CALCO SURVEYORS PTY LTD, DATED 12.02.2025, REF NO. 4653 DWG No. 001
- 2. THE INFORMATION SHOWN IS PROVIDED AS A BASIS FOR THE DESIGN. WALLACE DESIGN GROUP DOES NOT GUARANTEE THE ACCURACY OR COMPLETENESS OF THE SURVEY BASE OR ITS SUITABILITY AS A BASIS FOR CONSTRUCTION DRAWINGS.
- 3. SHOULD DISCREPANCIES BE ENCOUNTERED DURING CONSTRUCTION BETWEEN THE SURVEY DATA AND ACTUAL FIELD DATA, CONTRACTOR SHALL CONTACT CALCO SURVEYORS PTY LTD AND OR WALLACE DESIGN GROUP FOR CLARIFICATION.
- 4. THE CONTRACTOR SHALL ARRANGE ALL SURVEY SETOUT TO BE CARRIED OUT BY A REGISTERED SURVEYOR.

STORMWATER NOTES

- THESE DRAWINGS ARE TO BE READ IN CONJUNCTION WITH RELEVANT ARCHITECTURAL DETAILS.
- ALL WORKS ARE TO BE IN ACCORDANCE WITH AS3500, COUNCIL'S DEVELOPMENT CONTROL PLAN AND PROPRIETARY MANUFACTURERS RECOMMENDATIONS.
- 3. UNLESS OTHERWISE STATED, ALL STORMWATER PIPES (INCLUDING DOWNPIPES AND RAINWATER TANK OVERFLOW PIPES) ARE TO BE uPVC SEWER GRADE, U.N.O JOINTED & INSTALLED TO MANUFACTURERS RECOMMENDATIONS.
- 4. ALL uPVC STORMWATER LINES TO HAVE ALL JOINTS, INC. DOWNPIPE CONNECTIONS, FULLY SOLVENT WELDED, INCLUDING ANY CHARGED LINES.
- 5. CONNECT DOWNPIPES AS REQUIRED TO NOMINATED HARVESTING TANK IN ACCORDANCE WITH APPROVED DEVELOPMENT PLANS AND HYDRAULIC ENGINEERS DESIGN.
- 6. ALL LEVELS ARE DATUM AHD.
- 7. ALL LEVELS ARE FINISHED PAVEMENT OR LAWN LEVELS.
 - CONTRACTOR TO ALLOW FOR ALL PIPE SUPPORT SYSTEM TO SOFFIT AS PER MANUFACTURERS SPECIFICATIONS.
- 9. ALL CONCRETE TO BE MANUFACTURED AND SUPPLIED IN ACCORDANCE WITH AS1379.
- 10. AT COUNCILS DISCRETION, ALL CONCRETE CAN BE SUBJECT TO PROJECT ASSESSMENT AND TESTING TO AS1379
- 11. MINIMUM PIPE COVERS TO BE IN ACCORDANCE WITH AS3500.
- 12. PITS TO BE FILLED ACCORDINGLY TO MEET INVERTS AS NEEDED.
- 3. CONTRACTOR TO CONFIRM ALL LEVELS PRIOR TO CONSTRUCTION. ANY DISCREPANCIES ARE TO BE IMMEDIATELY REPORTED TO WALLACE DESIGN GROUP.


SUBSOIL DRAINAGE NOTES

- 1. CONSTRUCTION SHALL BE IN ACCORDANCE WITH COUNCIL'S CONSTRUCTION SPECIFICATIONS FOR SUBSURFACE DRAINAGE.
- 2. SUBSOIL PIPE TO BE Ø100 SLOTTED PVC OR CORRUGATED CIRCULAR PLASTIC PIPE AND ENCLOSED IN SEAMLESS FILTER FABRIC SOCK
- SUBSOIL DRAINS SHALL CONSIST OF A 300 (MINIMUM) WIDE TRENCH, BACKFILLED WITH 7 OR 10mm AGGREGATE AND WRAPPED IN BIDIM A12 GEOTEXTILE FABRIC OR SIMILAR, LAPPED AT THE TOP. DEPTH OF TRENCH TO EXTEND 450 (MINIMUM) IN ROCK OR 600 (MINIMUM) IN EARTH BELOW FINISHED SUB-GRADE LEVEL. INVERT OF TRENCH SHOULD ALSO BE LOWER THAN THE INVERT OF ANY SERVICE CROSSINGS.

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OMMENCEMENT OF ANY WORKS





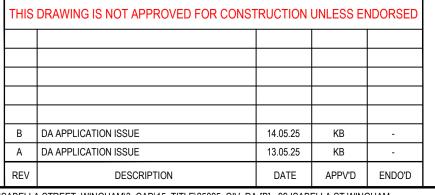

D & J CETINIC

37 Patriot Place

Rouse Hill NSW 2155



PROJECT:
CIVIL WORKS for
LOT 01, DP 925163
99 ISABELLA STREET
WINGHAM NSW 2429

DRAWING TITLE:

CIVIL SERVICES

GENERAL NOTES

DRAWING STATUS

DA APPROVAL
NOT TO BE USED FOR CONSTRUCTION

SCALE:

N.T.S.

ORIG. SIZE


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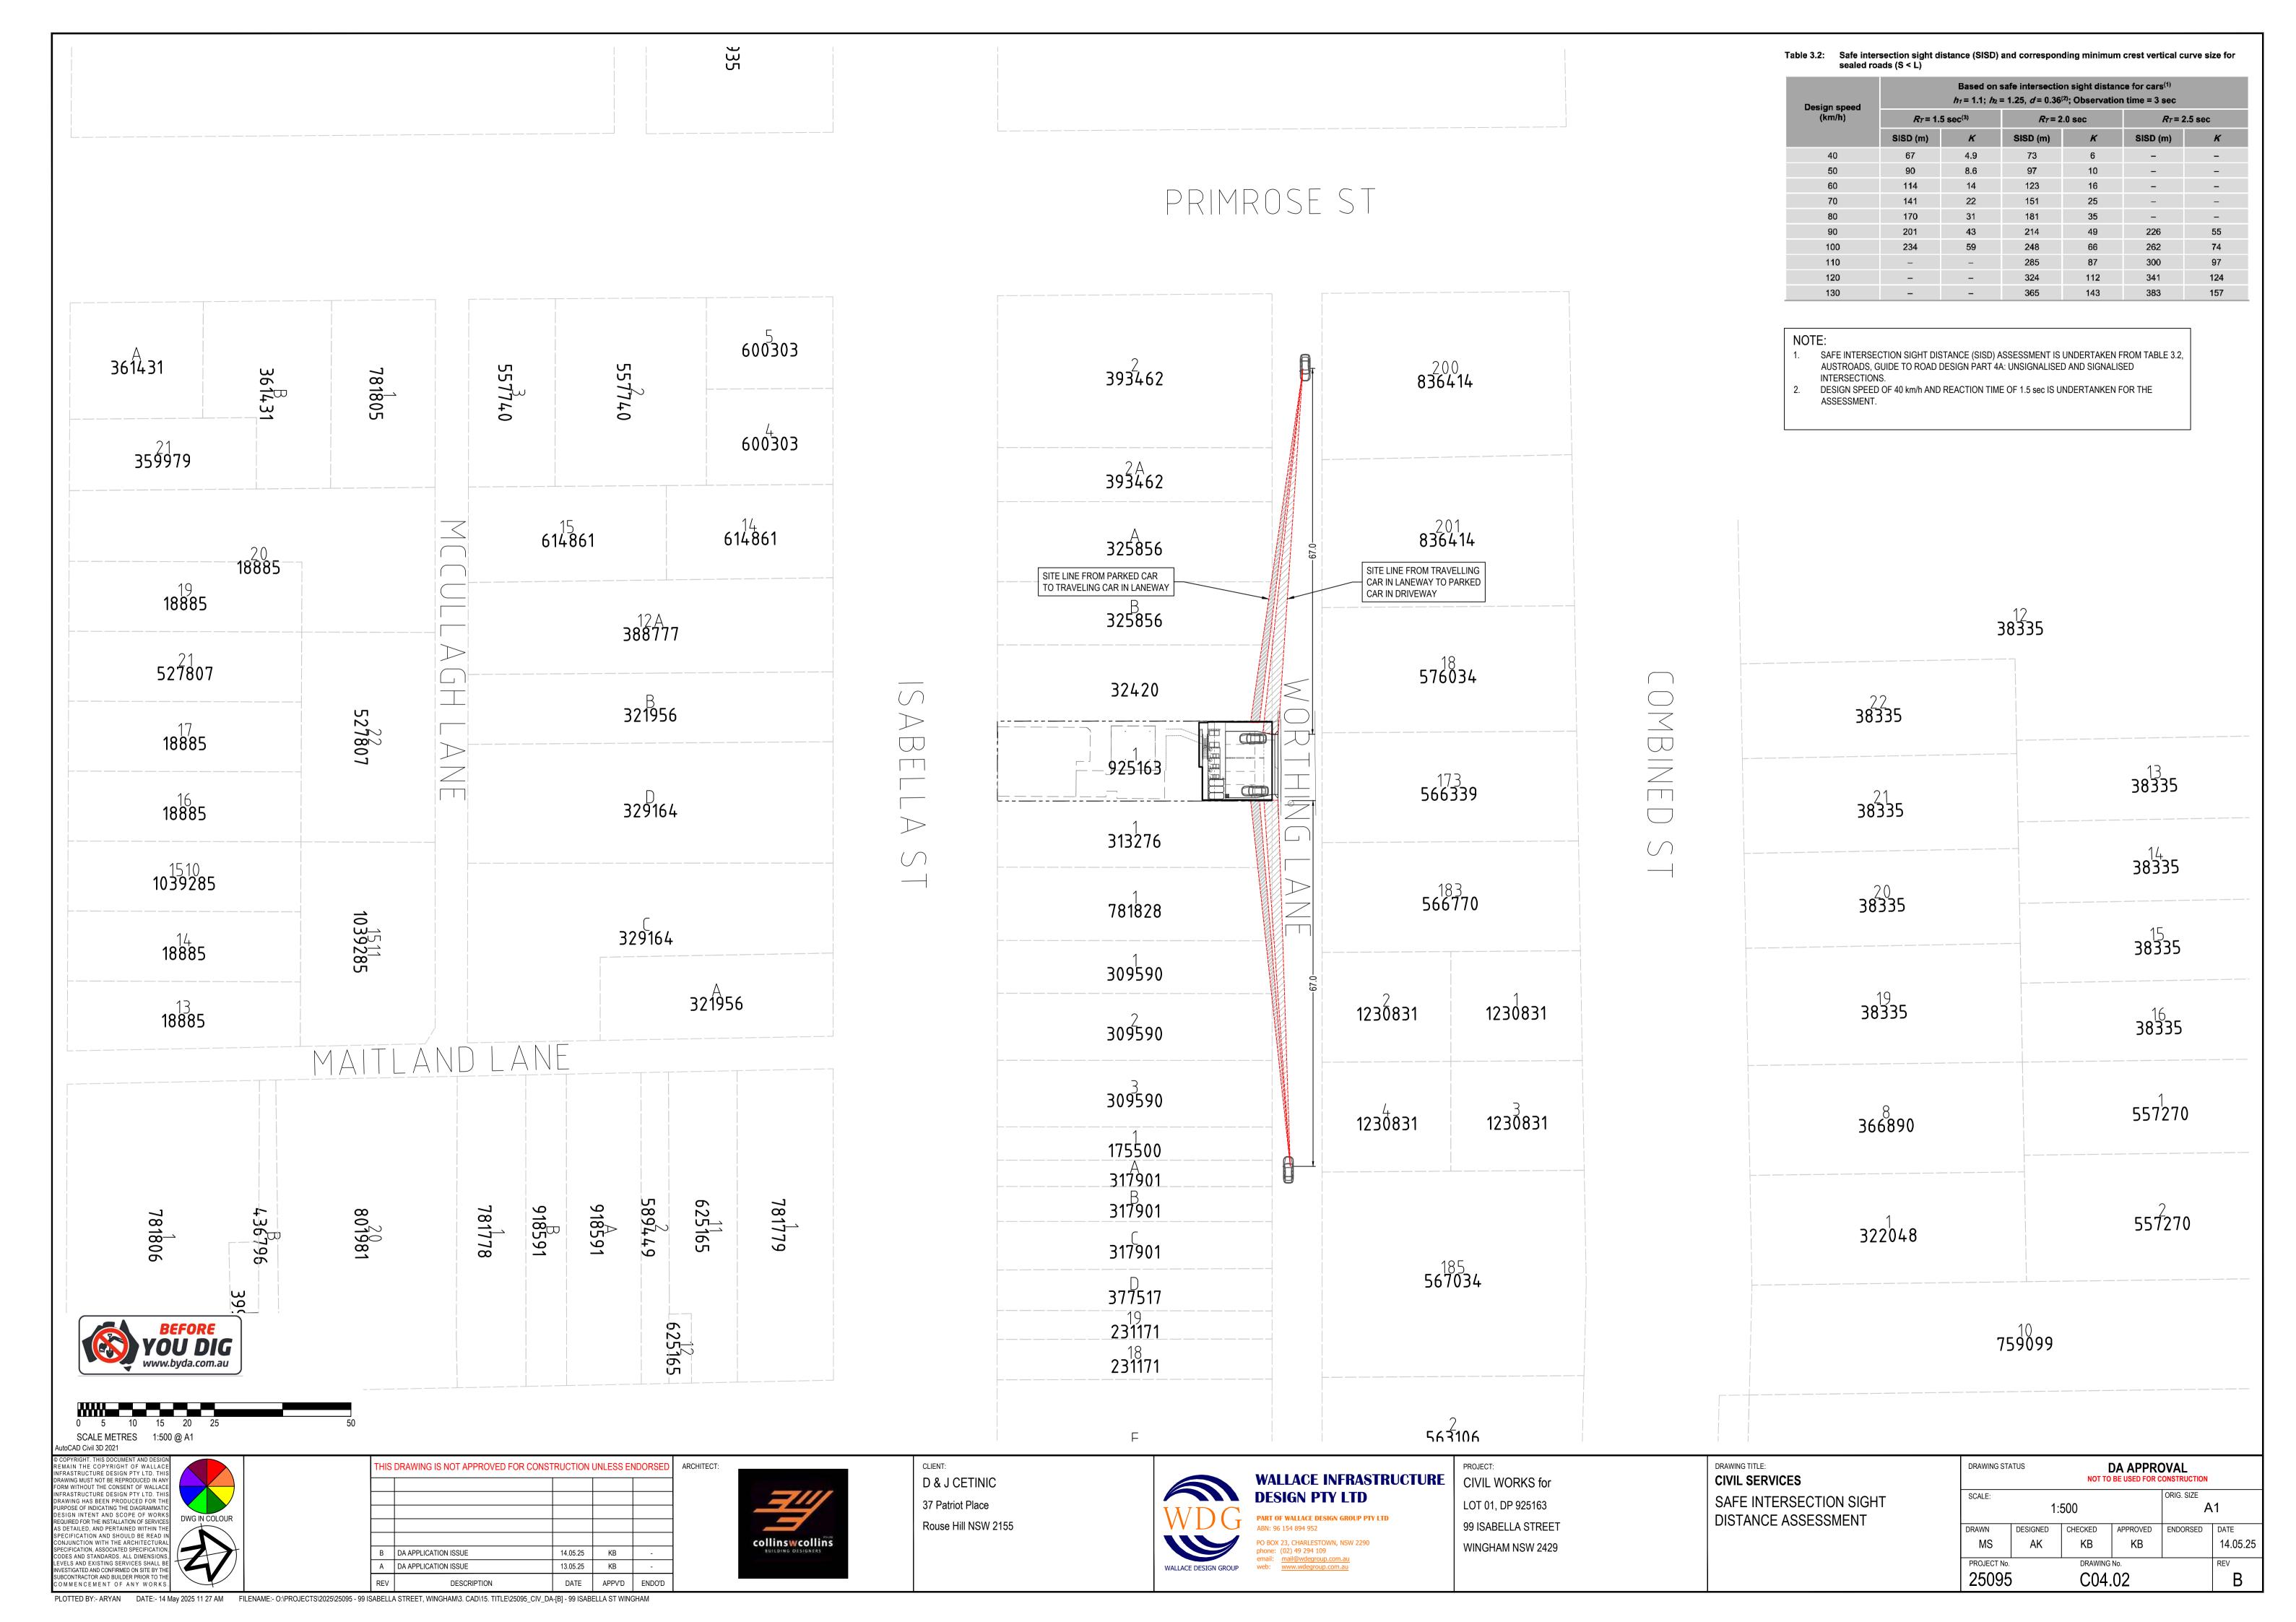
DRAWN
DESIGNED
CHECKED
APPROVED
ENDORSED
DATE
14.05.25

PROJECT No.
DRAWING No.
CO2.01

B

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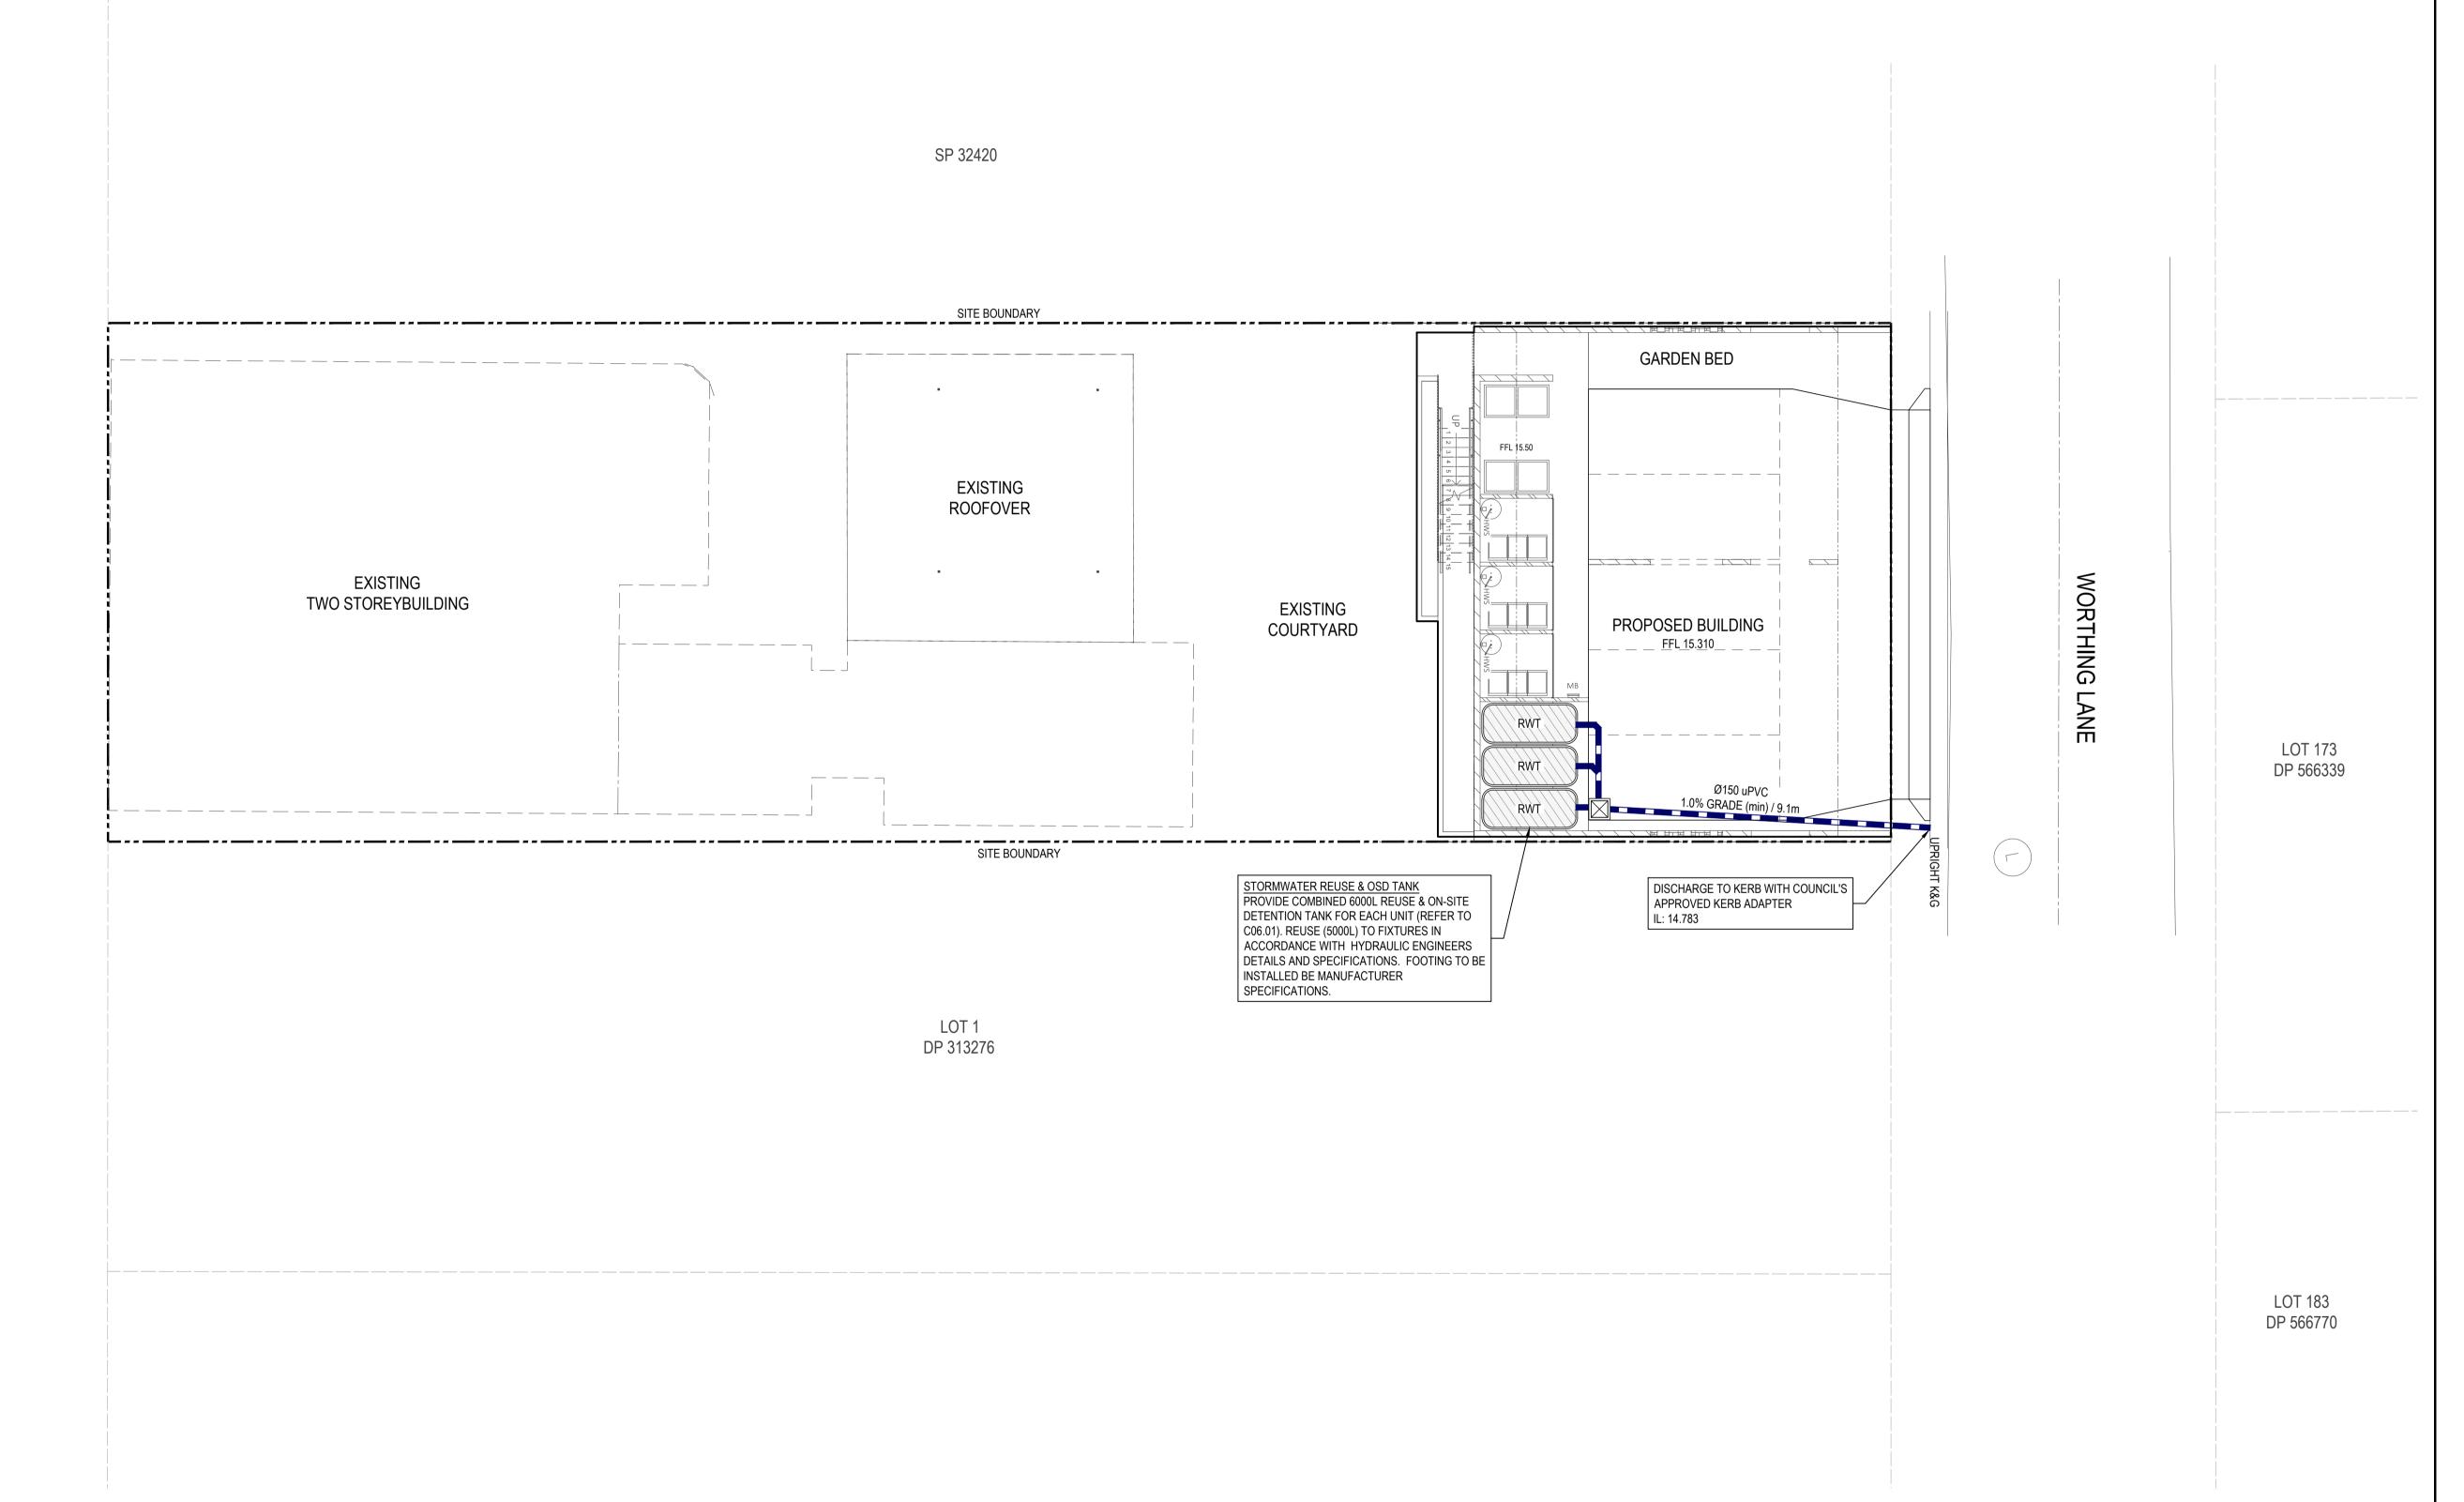


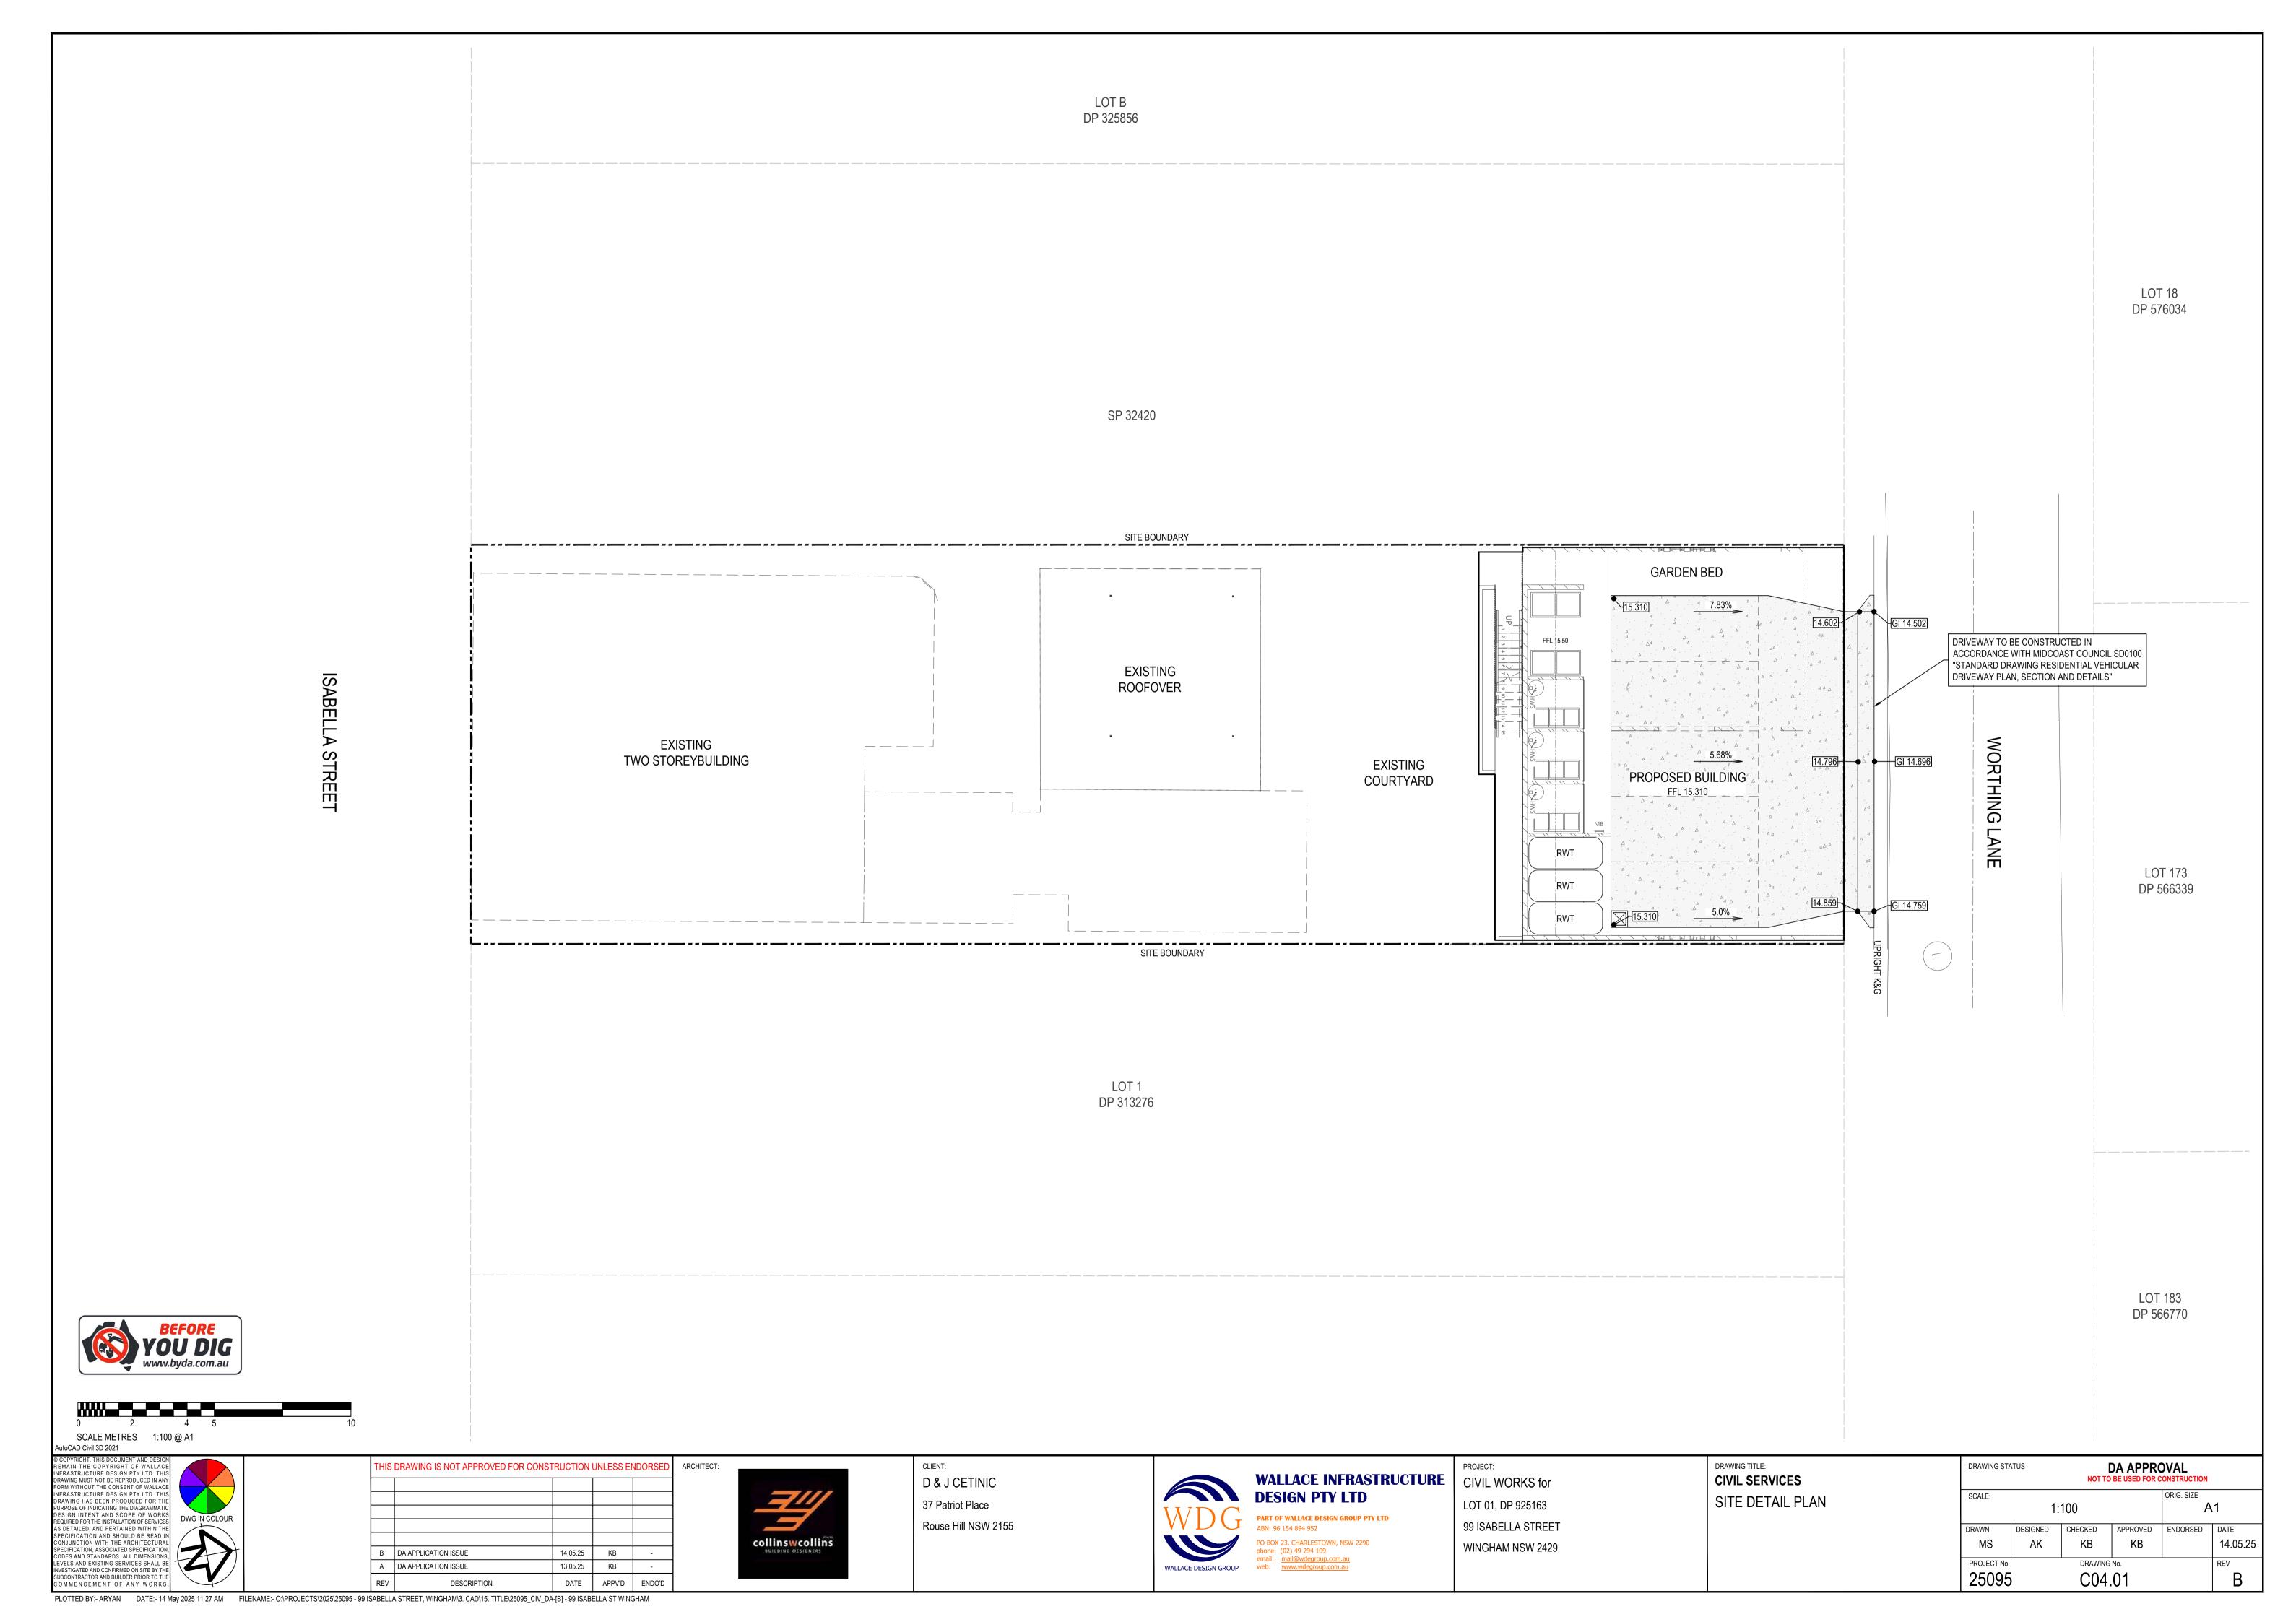

LOT B DP 325856

STORMWATER DETENTION RESULTS				
DESCRIPTION / STORM EVENT	20% AEP	5% AEP	1% AEP	
PRE-DEVELOPED PEAK FLOW (L/s)	25	39	59	
DEVELOPED PEAK FLOW (L/s) w/DETENTION	23	35	50	

- 1. STORMWATER ANALYSIS HAS BEEN COMPLETED USING DRAINS MODELLING SOFTWARE IN ACCORDANCE WITH BOOK 9, RUNOFF IN URBAN AREAS, AUSTRALIA RAINFALL AND RUNOFF, A GUIDE TO FLOOD ESTIMATING, 2019.
- 2. ASSUMPTIONS FOR STORMWATER ANALYSIS INCLUDE:
 - BASIX REQUIREMENT EXCLUDED FROM ANALYSIS. - RAINWATER REUSE VOLUMES EXCLUDED FROM PRELIMINARY ANALYSIS.



SCALE METRES 1:100 @ A1 AutoCAD Civil 3D 2021

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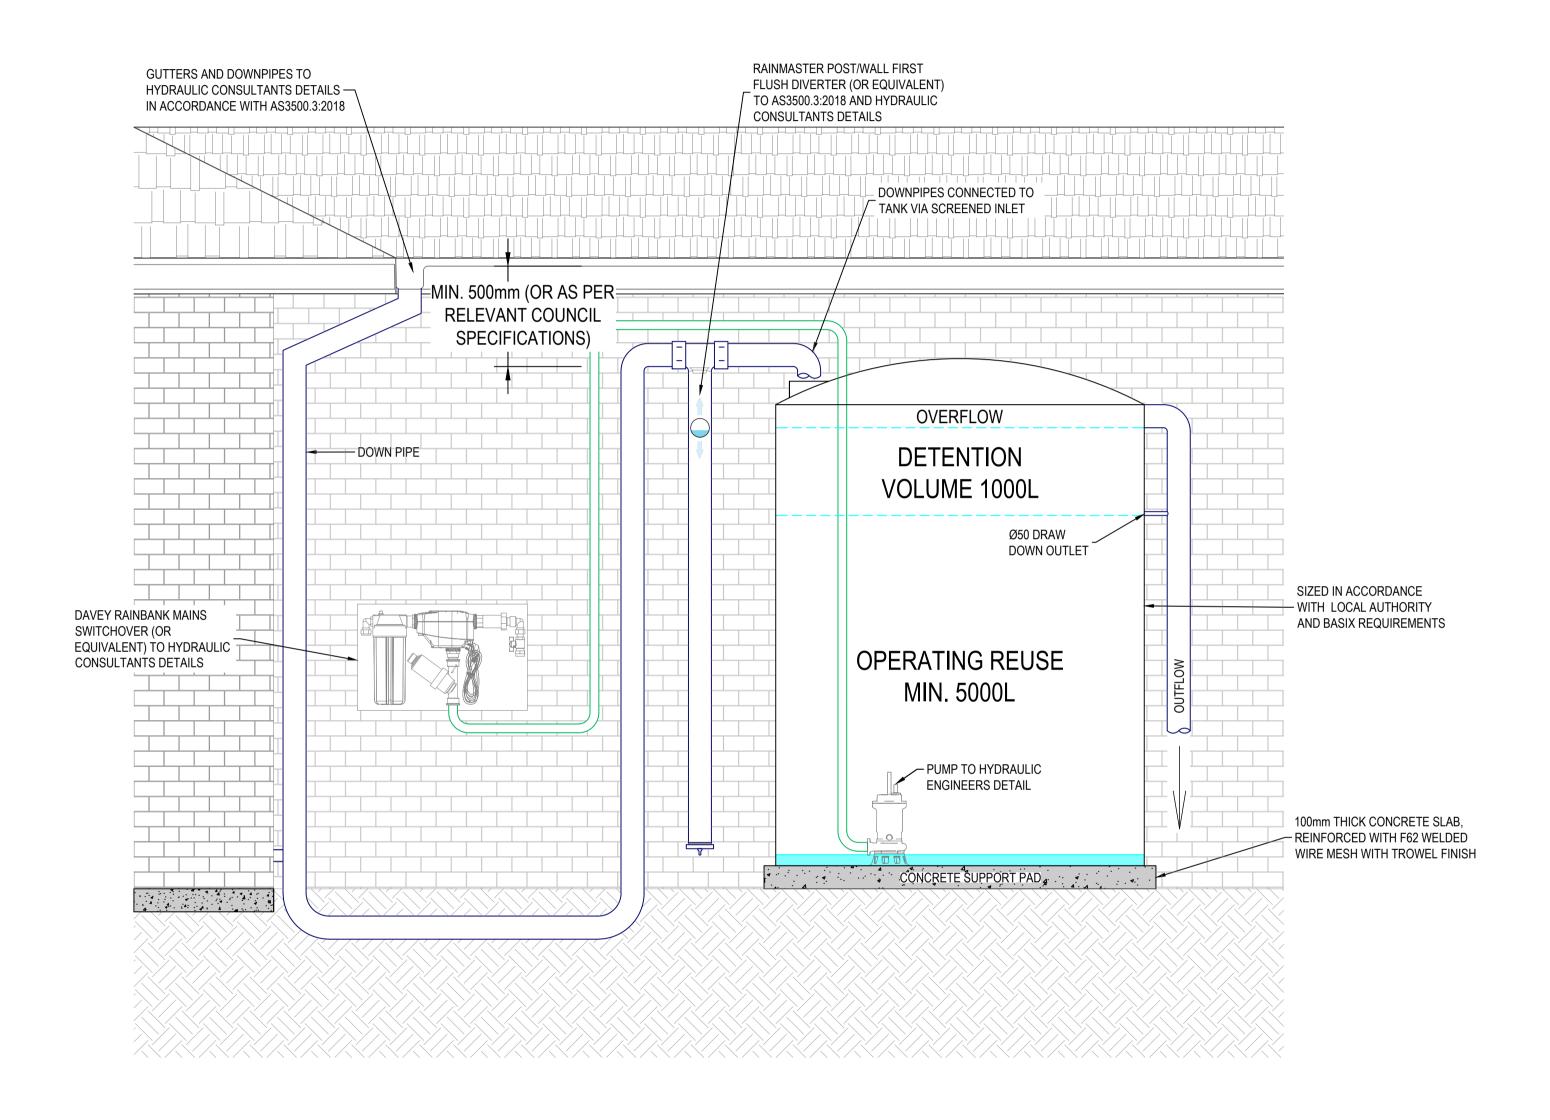
PROJECT: LOT 01, DP 925163 99 ISABELLA STREET WINGHAM NSW 2429

DRAWING TITLE: **CIVIL SERVICES** STORMWATER MANAGEMENT PLAN

DRAWING STA	ATUS		DA APPROBE USED FOR C	_	
SCALE:				ORIG. SIZE	
1:100				A	.1
DRAWN	DESIGNED	CHECKED	APPROVED	ENDORSED	DATE
MS	AK	KB	KB		14.05.25
PROJECT No.		DRAWING No.			REV
25095		C05.	01		В

GENERAL RAINWATER TANK NOTES:

- ALL UNITS ARE TO BE CONNECTED TO THE SPECIFIED RAINWATER REUSE/STORAGE TANK AS NOTED ON THE STORMWATER DRAINAGE PLAN SHEET.
- DAVEY RAINBANK MAINS SWITCHOVER (OR EQUIVALENT) AND RAINWATER TANK TO BE INSTALLED PER MANUFACTURERS SPECIFICATIONS.
- VOLUMES SHOWN FOR REUSE AND DETENTION ARE PROVIDED TO COMPLY WITH BASIX AND/OR COUNCIL GUIDELINES AND DO NOT INCLUDE THE PERMANENT VOLUME REQUIRED FOR OPERATION OF THE PUMP.



TYPICAL ABOVEGROUND RAINWATER REUSE TANK SECTION

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LOT 01, DP 925163 99 ISABELLA STREET WINGHAM NSW 2429

DRAWING TITLE: **CIVIL SERVICES** RAINWATER TANK TYPICAL SECTIONS & DETAILS

DRAWING STATUS DA APPROVAL NOT TO BE USED FOR CONSTRUCTION					
SCALE: N.T.S.				ORIG. SIZE	
DRAWN	DESIGNED	CHECKED	APPROVED	ENDORSED	DATE
MS	AK	KB	KB		14.05.25
PROJECT No. DRAWING No.			No.		REV
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